


REVISIONS


|-12-22 ADDED DEAD 22" & 29" LAUREL DAKS TO BE REMOVED AND 15" LAUREL OAI O BE RELOCATED. 6-9-22 REVISED SIDEWALK, PAY STATION AND DRIVE LOCATIONS.

A

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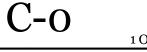
PROTECTION

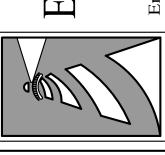


CLIENT INFORMATION: Andy Lazzaro Three Guys Car Wash, Llc 5520 Oleander Dr. Wilmington, NC 28403

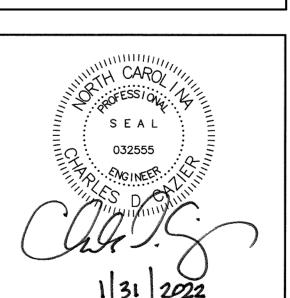DRAWN:	JAE	SHEET SIZE:	24 X 36
CHECKED:	CDC	DATE:	1/31/2022
APPROVED:	CDC	SCALE:	1" = 30'
PROJECT NUMBER:		2021-035	

DRAWING NUMBER:



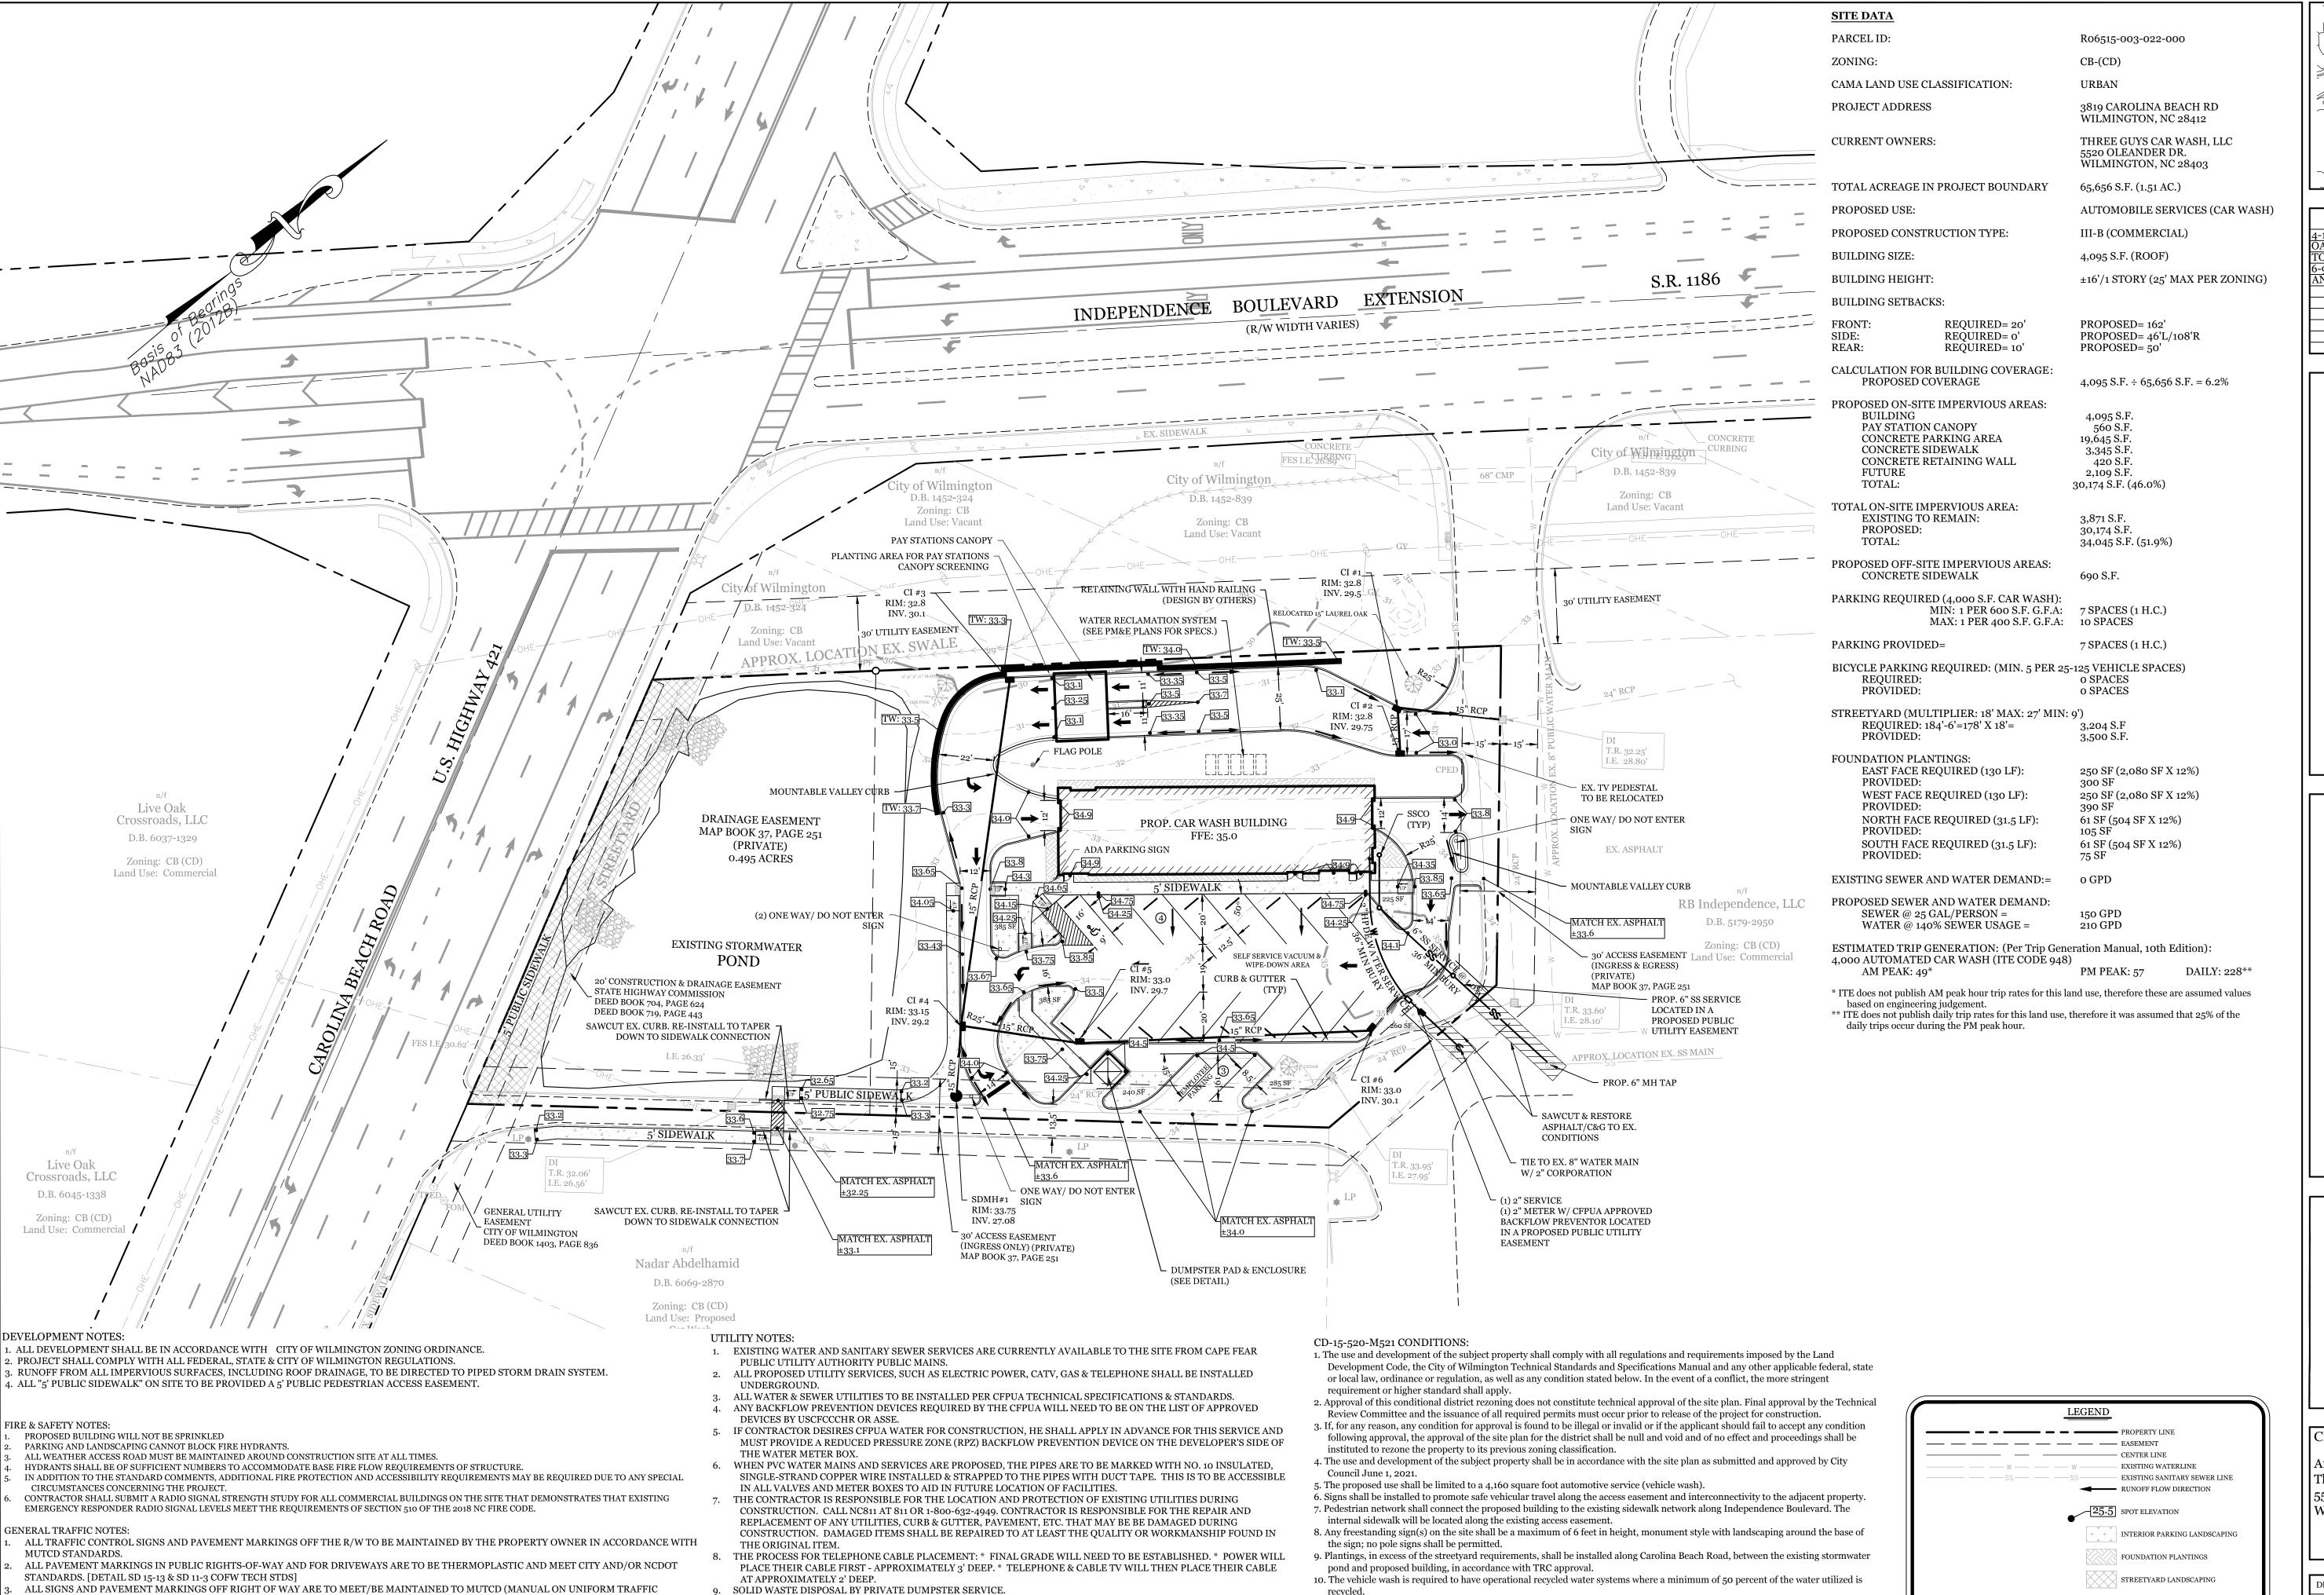

11. All City, State and Federal regulations shall be met.

the Independence Boulevard and Carolina Beach Road rights-of-way.

12. Additional plantings shall be provided to achieve an opaque screen for the payment station, located on the northwestern side of the

vehicle wash building, and for the entrance bay door, located on the southwestern side of the vehicle wash building, to screen from

10. 3' SEPARATION REQUIRED BETWEEN ALL JOINTS, FITTINGS AND SERVICE SADDLES.

11. NO FORMAL SITE LIGHTING IS PROPOSED. THERE MAY BE SOME SMALL LIGHTS INSTALLED ON THE BUILDING ITSELF.

CONTROL DEVICES) STANDARDS. [DETAIL SD 15-13 & SD 11-3 COFW TECH STDS]

DETAILS. IN CERTAIN CASES AN ENTIRE RESURFACING OF THE AREA BEING OPEN CUT MAY BE REQUIRED.

DETAILS. IN CERTAIN CASES AN ENTIRE RESURFACING OF THE AREA BEING OPEN CUT MAY BE REQUIRED.

CONTACT 811 PRIOR TO CONTACTING CITY OF WILMINGTON, TRAFFIC ENGINEERING REGARDING THE UTILITIES IN ROW.


ANY BROKEN OR MISSING SIDEWALK PANELS, DRIVEWAY PANELS AND CURBING WILL BE REPLACED.

STREET TREES MUST BE LOCATED A MINIMUM OF 15 FEET FROM STREET LIGHTS. [COFW SD 15-17]


A UTILITY CUT PERMIT IS REQUIRED FOR EACH OPEN CUT OF A CITY STREET. NOTE THIS ON THE PLAN AND CONTACT 341-5899 FOR MORE


A UTILITY CUT PERMIT IS REQUIRED FOR EACH OPEN CUT OF A CITY STREET. NOTE THIS ON THE PLAN AND CONTACT 341-5899 FOR MORE

ALL PROPOSED VEGETATION WITHIN SIGHT TRIANGLES SHALL NOT INTERFERE WITH CLEAR VISUAL SIGHT LINES FROM 30" TO 10'.

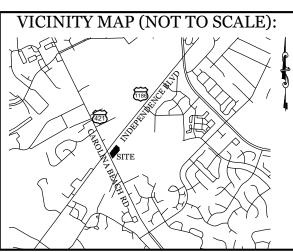

REVISIONS |-12-22 ADDED DEAD 22" & 29" LAUREL DAKS TO BE REMOVED AND 15" LAUREL OA O BE RELOCATED. 6-9-22 REVISED SIDEWALK, PAY STATION AND DRIVE LOCATIONS.

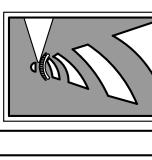


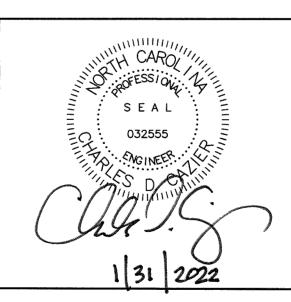

CLIENT INFORMATION: Andy Lazzaro Three Guys Car Wash, Llc 5520 Oleander Dr. Wilmington, NC 28403

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DRAWING NUMBER: C-1

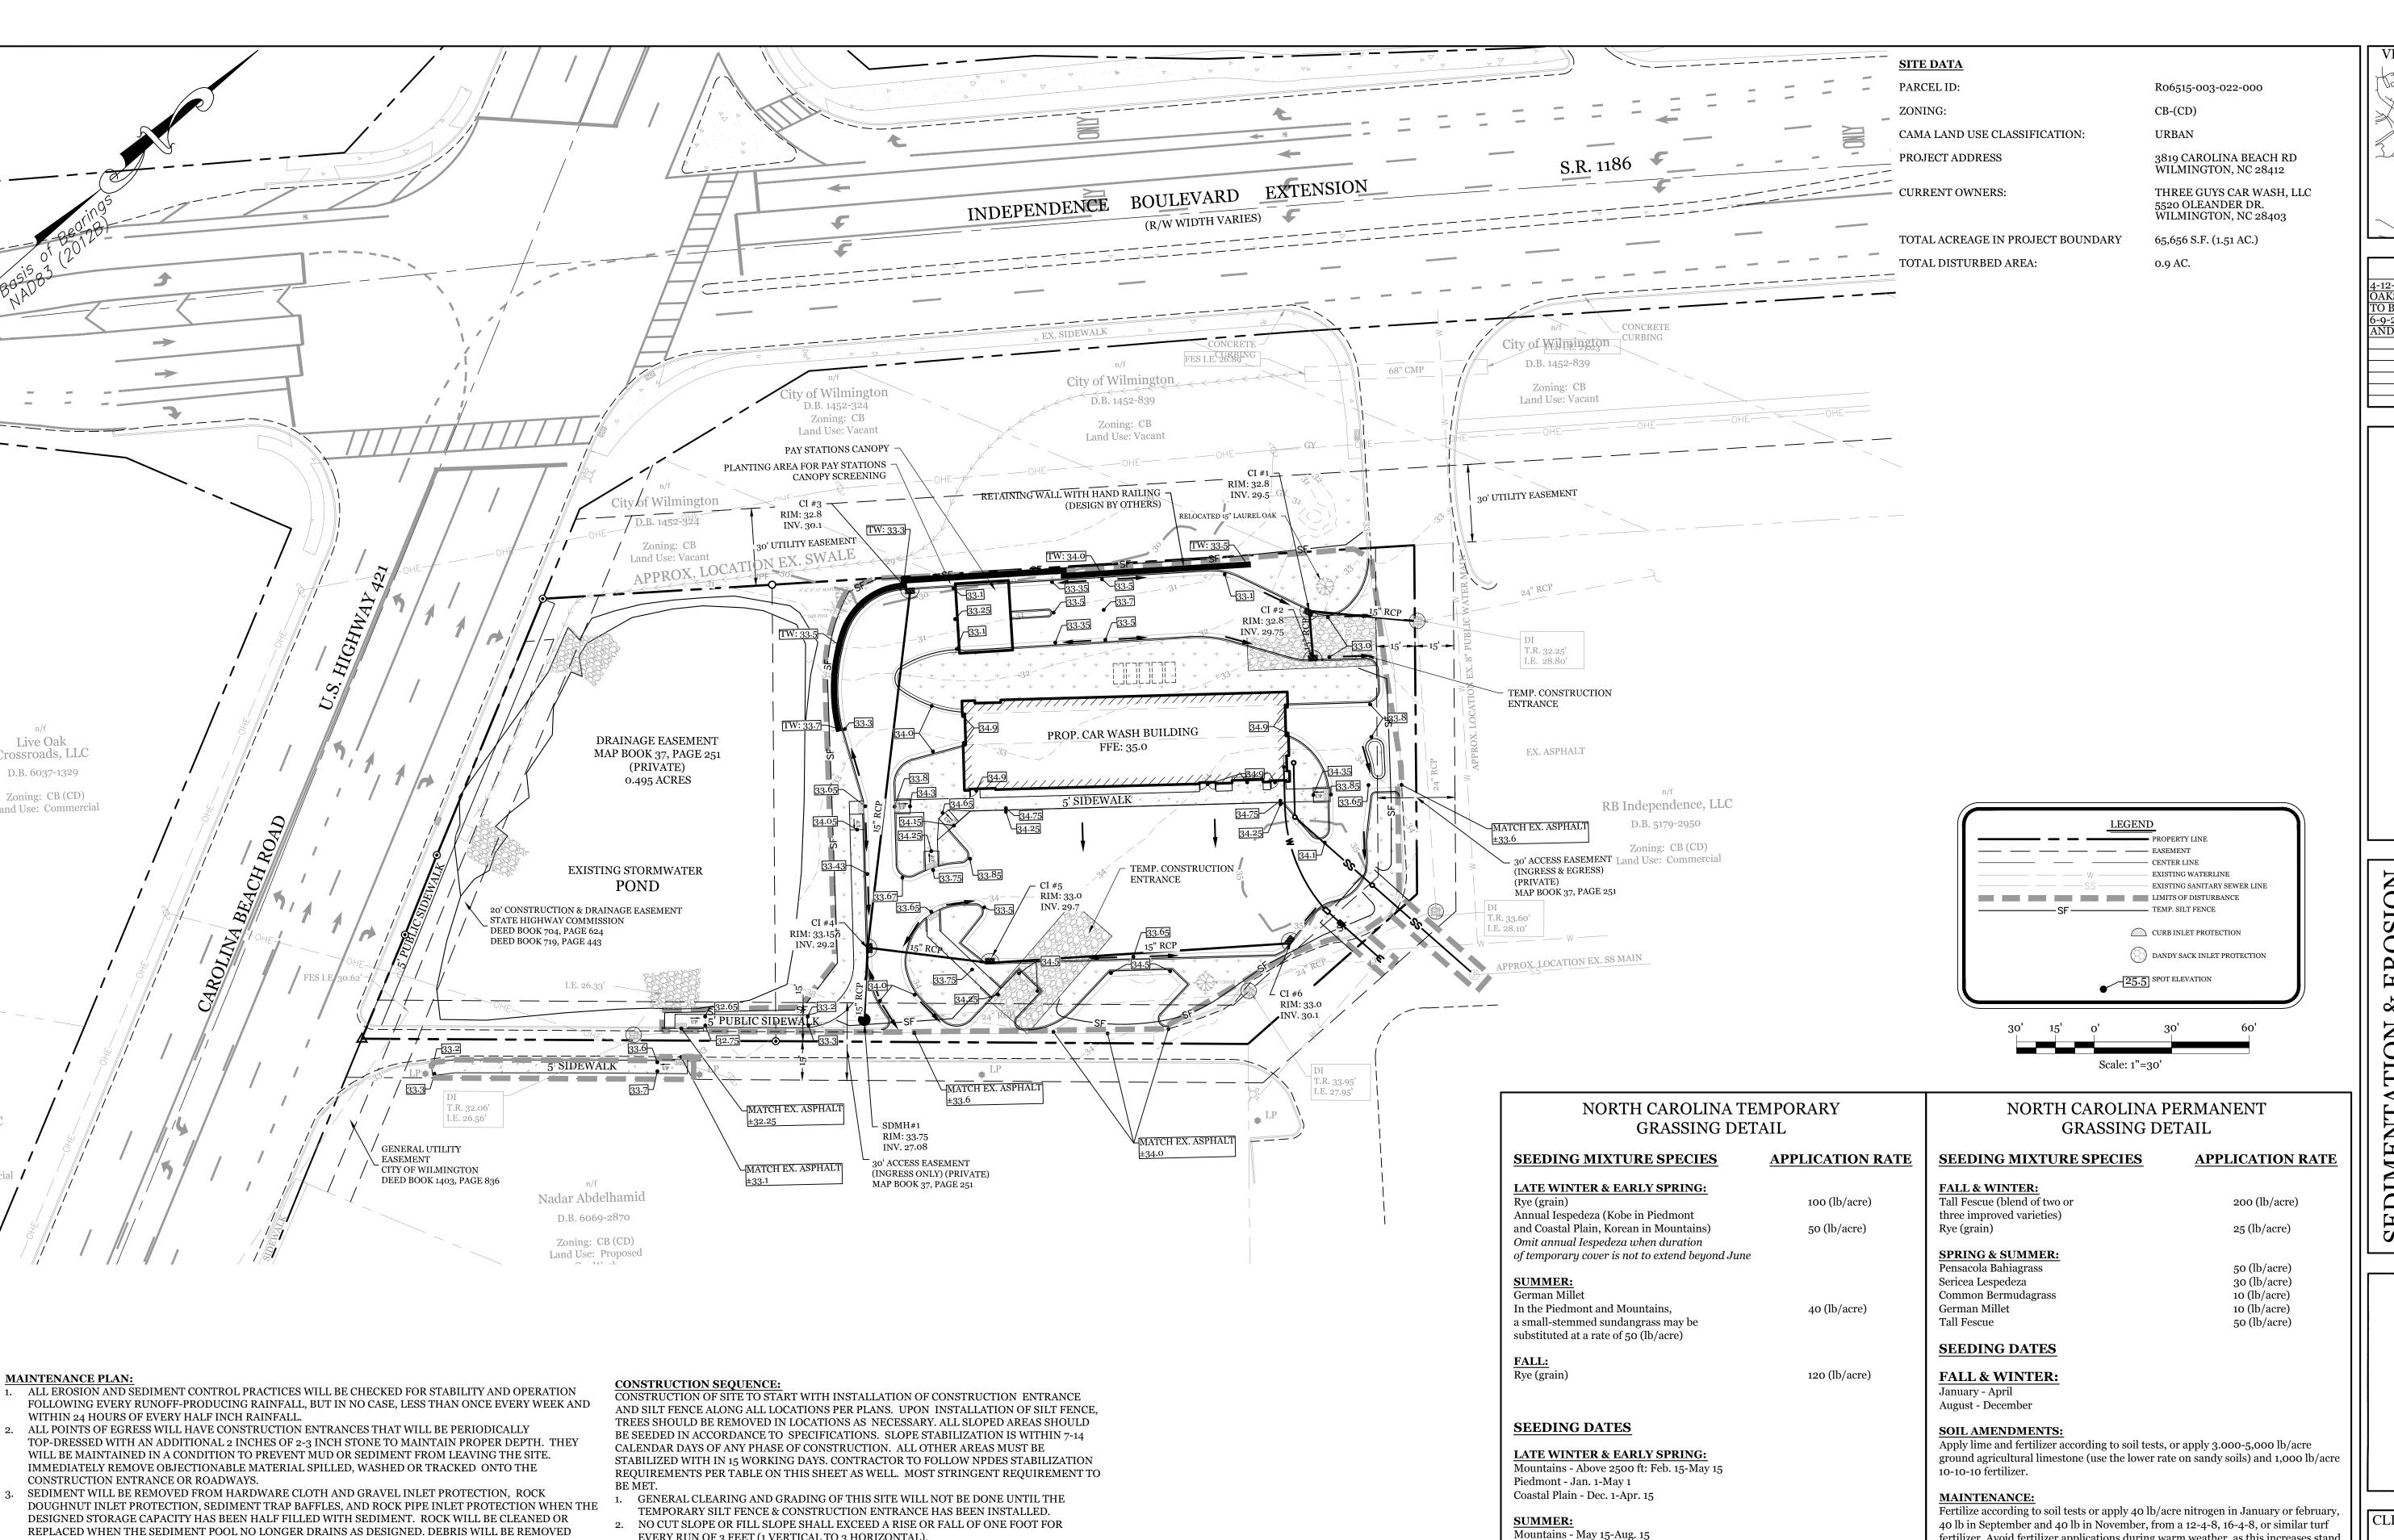

- FROM THE ROCK AND HARDWARE CLOTH TO ALLOW PROPER DRAINAGE. SILT SACKS WILL BE EMPTIED ONCE A WEEK AND AFTER EVERY RAIN EVENT. SEDIMENT WILL BE REMOVED FROM AROUND BEAVER DAMS, DANDY SACKS AND SOCKS ONCE A WEEK AND AFTER EVERY RAIN EVENT.
- SEDIMENT WILL BE REMOVED FROM BEHIND THE SEDIMENT FENCE WHEN IT BECOMES HALF FILLED. THE SEDIMENT FENCE WILL BE REPAIRED AS NECESSARY TO MAINTAIN A BARRIER. STAKES MUST BE STEEL. STAKE SPACING WILL BE 6 FEET MAX. WITH THE USE OF EXTRA STRENGTH FABRIC, WITHOUT WIRE BACKING. STAKE SPACING WILL BE 8 FEET MAX WHEN STANDARD STRENGTH FABRIC AND WIRE BACKING ARE USED. IF ROCK FILTERS ARE DESIGNED AT LOW POINTS IN THE IN THE SEDIMENT FENCE THE ROCK WILL BE REPAIRED OR REPLACED IF IT BECOMES HALF FULL OF SEDIMENT, NO LONGER DRAINS AS DESIGNED OR IS DAMAGED.
- EVERY RUN OF 3 FEET (1 VERTICAL TO 3 HORIZONTAL). 3. NO SEDIMENT WILL BE ALLOWED TO EXIT THE SITE. ALL EROSION SHALL BE
- INSTALL PRIMARY EROSION CONTROL MEASURES BEFORE BEGINNING CONSTRUCT. INCLUDING BUT NOT LIMITED TO GRAVELED CONSTRUCTION ENTRANCE, SILT FEN TREE PROTECTION FENCE & SEDIMENT BASINS. INSTALL ALL SECONDARY EROSION CONTROL MEASURES, SUCH AS INLET PROTECTION AS SOON AS POSSIBLE AFTER BEGINNING CONSTRUCTION.

CONTROLLED INCLUDING SIDE SLOPES DURING AND AFTER CONSTRUCTION

5. ALL EROSION CONTROL MEASURES TO BE INSPECTED AFTER EACH RAIN. SILT FENCE AND INLET PROTECTION TO BE CLEANED WHEN HALF FULL.

PLAN PROVE TO BE LESS EFFECTIVE.

- 6. A 4" LAYER OF TOPSOIL SHALL BE APPLIED TO ALL NEW AREAS TO BE GRASSED. MAINTAIN ALL EROSION CONTROL MEASURES UNTIL PROJECT IS COMPLETE. 8. MORE STRINGENT MEASURES MAY BE REQUIRED TO HALT EROSION IF THOSE ON T
- REMOVE ALL TEMPORARY EROSION CONTROL MEASURES UPON COMPLETION OF CONSTRUCTION. ALL PERMANENT MEASURES SHALL BE WELL ESTABLISHED PRIOR PROJECT COMPLETION.

1	SYMBOL	GROUND STABILIZATION CRITERIA			
		SITE AREA DESCRIPTION	STABILIZATION TIMEFRAME	STABILIZATION TIMEFRAME EXCEPTIONS	
		* Perimeter dikes, swales, ditches and slopes	7 Days	None	
		* High Quality Water (HQW) Zones	7 Days	None	
		* Slopes Steeper than 3:1	7 Days	If slopes are 10' or less in length and are not steeper than 2:1, 14 days are allowed	
	\(\frac{1}{\psi} \psi \psi \psi \psi \psi \psi \psi \psi	* Slopes 3:1 or flatter	14 Days	7-days for slopes greater than 50 ft. in length	
		* All other areas with slopes flatter than 4:1	14 Days	None (except for perimeters & HQW Zones)	

Piedmont - May 1-Aug. 15 Coastal Plain - Apr. 15-Aug. 15

Mountains - Aug. 15-Dec. 15 Coastal Plain and Piedmont - Aug. 15-Dec. 30

SOIL AMENDMENTS:

Follow recommendations of soil tests or apply 2,000 lb/acre ground agricultural limestone and 750 lb/acre 10-10-10 fertilizer.

MULCH:

apply 4,000 lb/acre straw. anchor straw by tacking with asphalt, netting, or a mulch anchoring tool. A disk with blades set nearly straight can be used as a mulc anchoring tool.

Refertilize if growth is not fully adequate. reseed, refertilize and mulch immediatel following erosion or other damage.

fertilizer. Avoid fertilizer applications during warm weather, as this increases stand losses to disease. Reseed, fertilize, and mulch damaged areas immediately. mow to a height of 2.5-3.5 inches as needed.

SPRING & SUMMER:


April 1 - July 15

Apply lime and fertilizer according to soil tests, or apply 3,000 lb/acre ground agriculture limestone and 500 lb/acre 10-10-10 fertilizer.


MAINTENANCE:

Refertilize the following april with 50 lb/acre nitrogen. Repeat as growth requires. may be moved only once a year. Where a neat appearance is desired, omit sericea and mow as often as needed.

apply 4,000 lb/acre straw. anchor straw by tacking with asphalt, netting, or a mulch anchoring tool. A disk with blades set nearly straight can be used as a mulch anchoring tool.

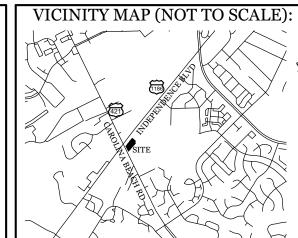

REVISIONS -12-22 ADDED DEAD 22" & 29" LAUREL AKS TO BE REMOVED AND 15" LAUREL OA O BE RELOCATED. -9-22 REVISED SIDEWALK, PAY STATION ND DRIVE LOCATIONS.

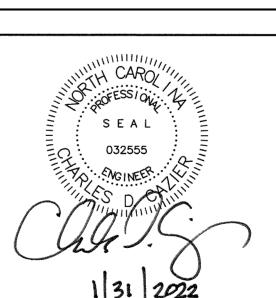

CLIENT INFORMATION:

Andy Lazzaro Three Guys Car Wash, Llc 5520 Oleander Dr. Wilmington, NC 28403


DRAWN:	JAE	SHEET SIZE:	24 X 36
CHECKED:	CDC	DATE:	1/31/2022
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2021-035

DRAWING NUMBER:

PROJECT NUMBER:



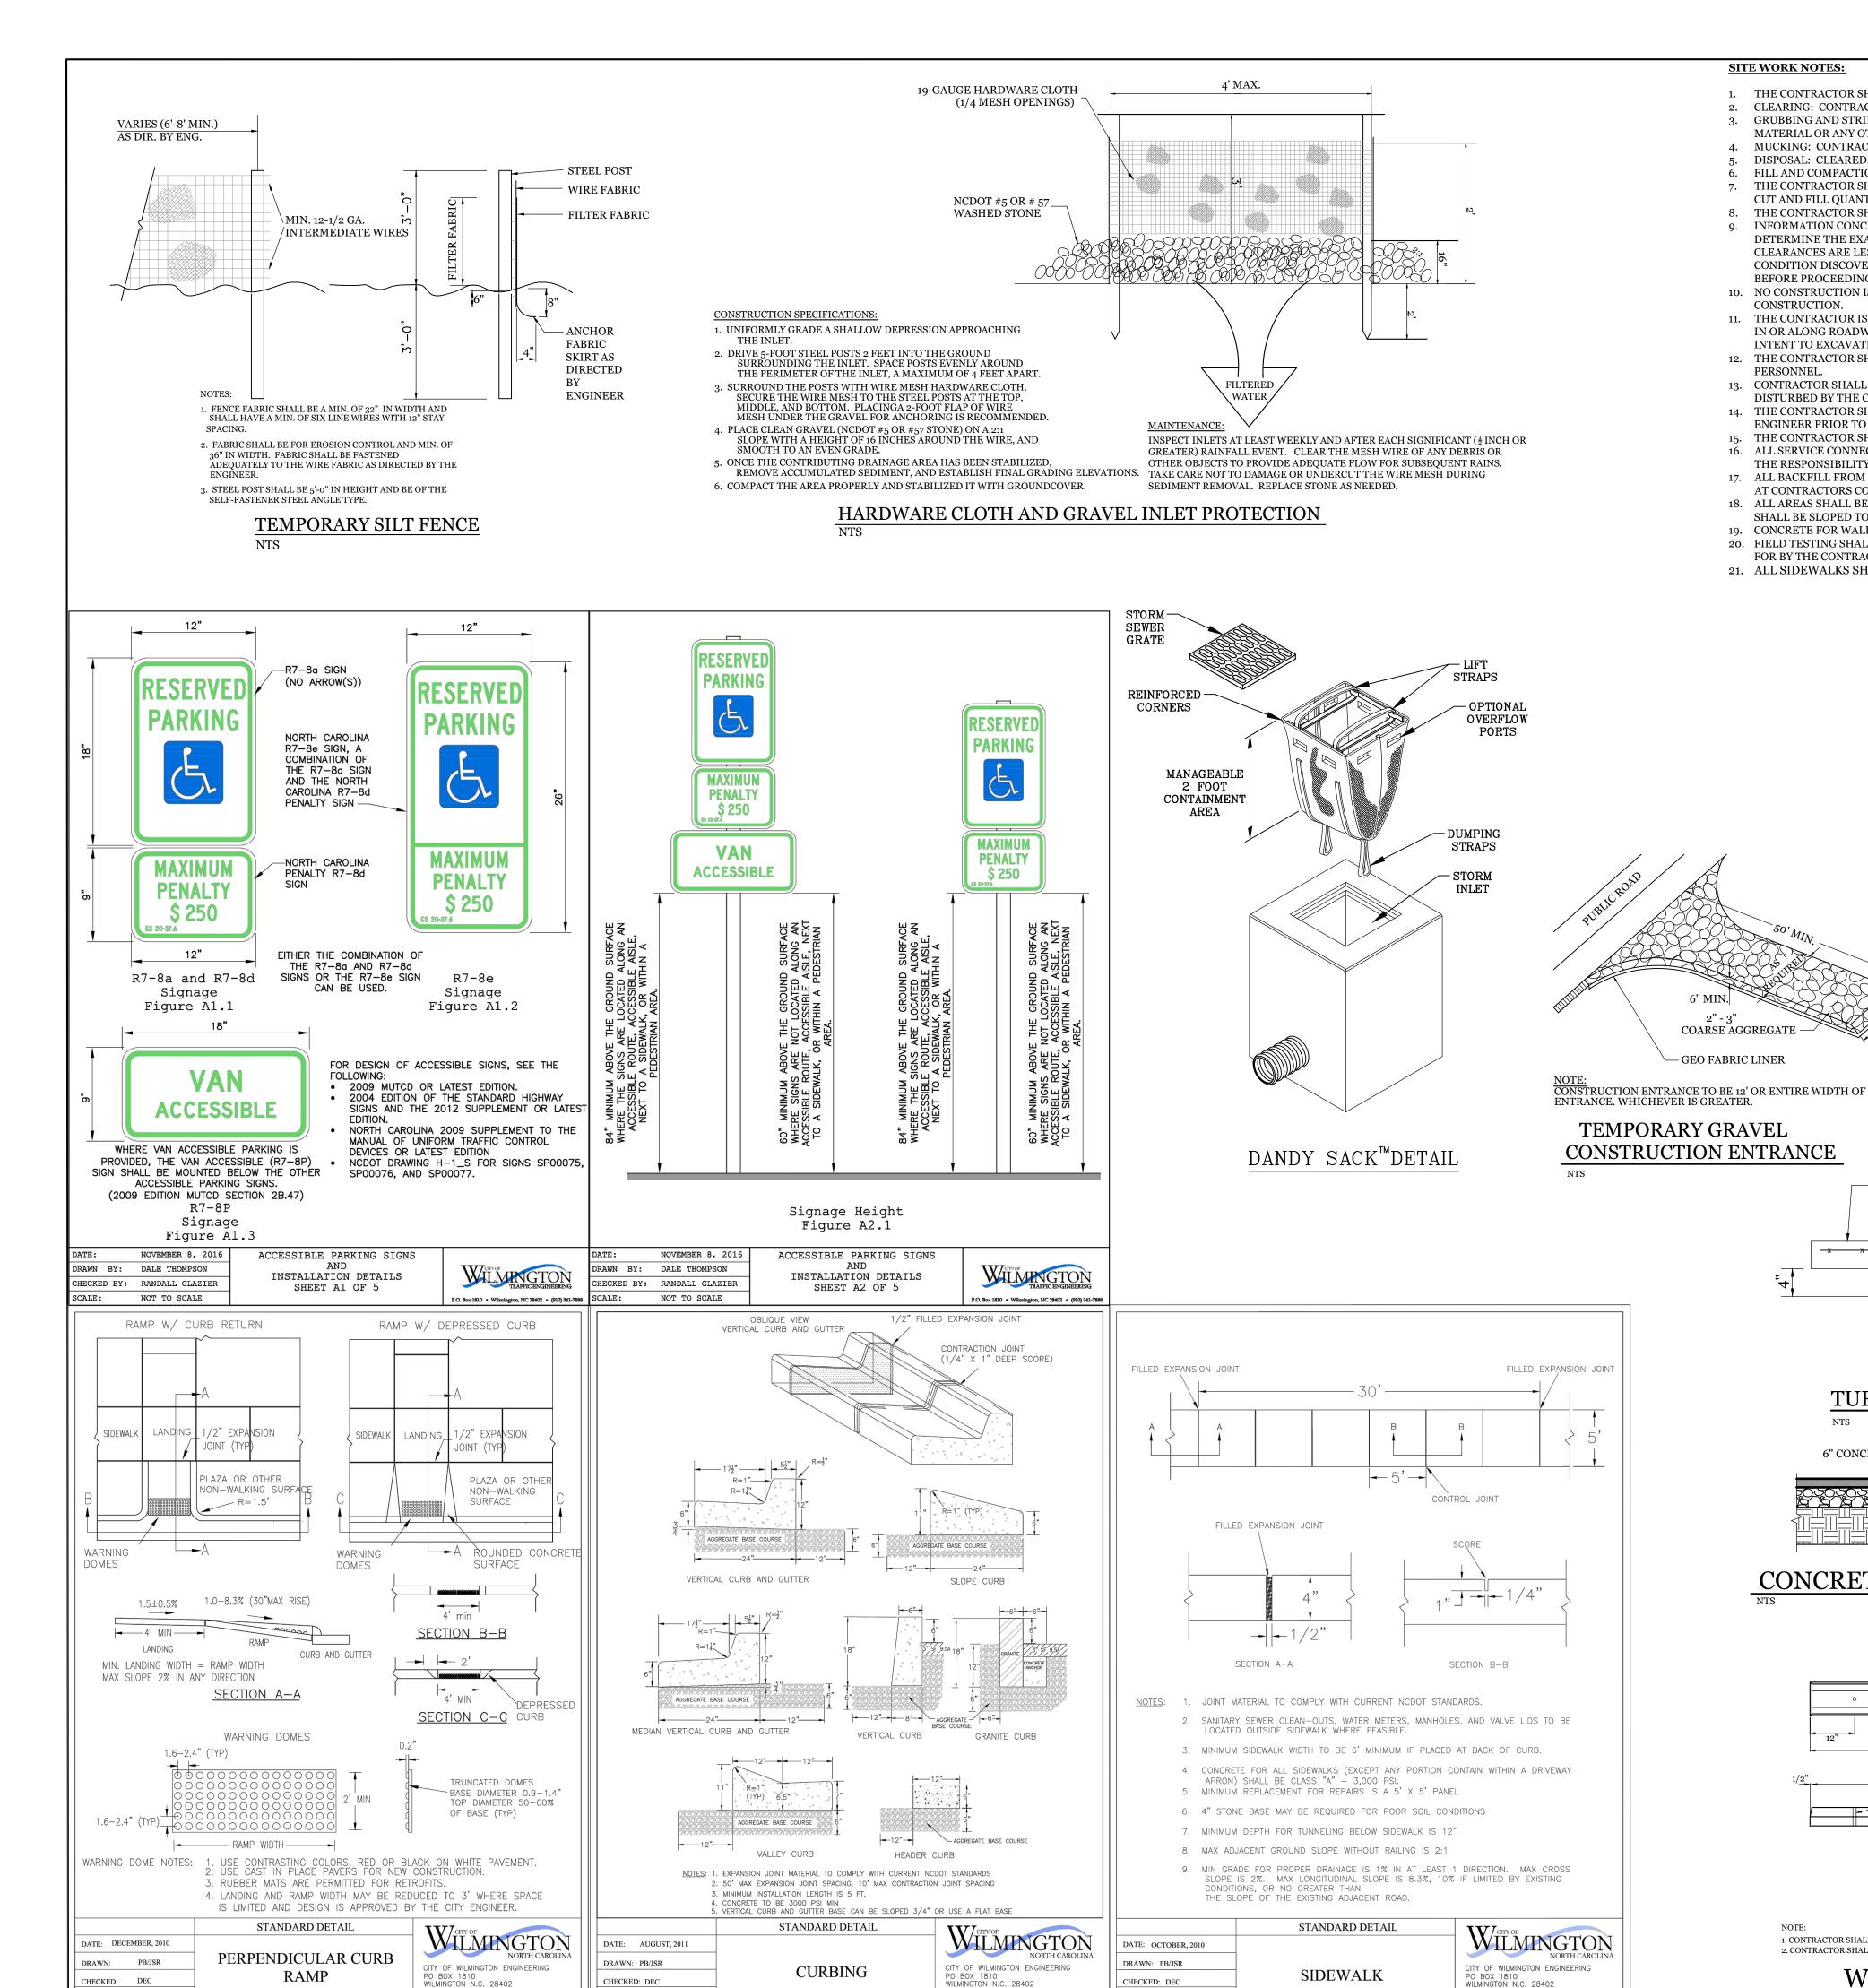

CHECKED: DEC

SCALE NOT TO SCALE

SD 3-11

CHECKED: DEC

SCALE ____NOT TO SCALE_

SD3-08

CHECKED: DEC

SCALE NOT TO SCALE

ADJACENT TO PLAZA

SITE WORK NOTES:

1. THE CONTRACTOR SHALL VISIT THE SITE AND BECOME FAMILIAR WITH EXISTING CONDITIONS BOTH ON AND ADJACENT TO THE SITE.

MATERIAL OR ANY OTHER UNSUITABLE MATERIAL WITHIN LIMITS OF CONSTRUCTION

CLEARING: CONTRACTOR SHALL REMOVE ALL TREES AND VEGETATION WITHIN LIMITS OF CONSTRUCTION UNLESS OTHERWISE DESIGNATED TO REMAIN. GRUBBING AND STRIPPING: CONTRACTOR SHALL RAKE AND REMOVE ROOTS, STUMPS, VEGETATION, DEBRIS, EXISTING STRUCTURES ABOVE AND BELOW GRADE, ORGANIC

MUCKING: CONTRACTOR SHALL COORDINATE WITH OWNER AND THEIR GEOTECHNICAL REPRESENTATIVE TO COORDINATE REMOVAL OF ANY SOFT AREAS.

DISPOSAL: CLEARED, GRUBBED, STRIPPED OR OTHER WASTE MATERIAL SHALL BE REMOVED FROM SITE AND DISPOSED OF IN A PROPERLY PERMITTED FACILITY. FILL AND COMPACTION SHOULD COMPLY WITH GEOTECHNICAL RECOMMENDATIONS.

THE CONTRACTOR SHALL NOTE THAT THE GRADING PLAN MAY NOT REPRESENT A BALANCED EARTHWORK CONDITION. THE CONTRACTOR SHALL BE RESPONSIBLE FOR CUT AND FILL QUANTITIES AND COMPLETE INSTALLATION TO SPECIFIED GRADES.

8. THE CONTRACTOR SHALL FURNISH SUITABLE BORROW MATERIAL FROM AN OFF-SITE PROPERLY PERMITTED FACILITY AS REQUIRED CLEARANCES ARE LESS THAN INDICATED ON PLAN, THE CONTRACTOR SHALL CONTACT THE DESIGN ENGINEER BEFORE PROCEEDING WITH CONSTRUCTION, ANY BEFORE PROCEEDING WITH CONSTRUCTION.

10. NO CONSTRUCTION IS TO BEGIN BEFORE LOCATION OF EXISTING UTILITIES HAS BEEN DETERMINED. CALL "NC ONE-CALL" AT LEAST 48 HOURS BEFORE COMMENCING

11. THE CONTRACTOR IS RESPONSIBLE FOR THE LOCATION AND PROTECTION OF ALL EXISTING UTILITIES DURING CONSTRUCTION. BEFORE COMMENCING ANY EXCAVATIONS IN OR ALONG ROADWAYS OR RIGHT-OF-WAYS, PUBLIC AREAS OR IN PRIVATE EASEMENTS, THE CONTRACTOR SHALL NOTIFY ALL APPROPRIATE PERSONNEL OF THEIR INTENT TO EXCAVATE, IN WRITING, NOT LESS THAN 10 DAYS PRIOR TO EXCAVATING.

12. THE CONTRACTOR SHALL BE RESPONSIBLE TO COORDINATE DISCONNECTION/ RECONNECTION AND/OR THE RELOCATION OF ALL EXISTING UTILITIES WITH APPROPRIATE 13. CONTRACTOR SHALL ADJUST ALL MANHOLES, VALVE & CURB BOXES TO FINAL GRADE UPON COMPLETION OF ALL CONSTRUCTION. ANY BOXES DAMAGED OR OTHERWISE

DISTURBED BY THE CONTRACTOR SHALL BE REPAIRED AT THE EXPENSE OF THE CONTRACTOR. 14. THE CONTRACTOR SHALL FIELD VERIFY ALL DIMENSIONS AT THE SITE. FURTHERMORE THE CONTRACTOR SHALL REPORT ALL DISCREPANCIES OR QUESTIONS TO THE

ENGINEER PRIOR TO INSTALLATION.

16. ALL SERVICE CONNECTIONS SHALL BE INSTALLED TO MEET ALL LOCAL, STATE, AND CFPUA CODES. METERS, TAPS, MATERIALS, WORKMANSHIP AND ALL FEES SHALL BE THE RESPONSIBILITY OF THE CONTRACTOR AND SHALL COMPLY WITH ALL REQUIREMENTS.

17. ALL BACKFILL FROM UTILITY INSTALLATION MUST BE COMPACTED OR AMENDED TO PROVIDE TRAFFIC BEARING CAPACITY. GEOTECHNICAL ENGINEER TO BE CONSULTED AT CONTRACTORS COST AS NECESSARY.


18. ALL AREAS SHALL BE GRADED FOR POSITIVE DRAINAGE. CONTRACTOR SHALL REPORT ANY DISCREPANCIES TO THE ENGINEER PRIOR TO INSTALLATION. ALL AREAS SHALL BE SLOPED TO DRAIN AWAY FROM BUILDINGS AT ALL TIMES.


19. CONCRETE FOR WALKS, CURBS AND DRIVES SHALL HAVE A MINIMUM COMPRESSIVE STRENGTH OF 3000 PSI @ 28 DAYS - AIR ENTRAINEI

20. FIELD TESTING SHALL BE DONE BY AN INDEPENDENT TESTING LABORATORY PAID FOR BY THE OWNER. FURTHER TESTING REQUIRED DUE TO A FAILED TEST WILL BE PAID FOR BY THE CONTRACTOR.

21. ALL SIDEWALKS SHALL BE FREE OF CRACKS, BREAKS, OR ANY OTHER DEFECT PRIOR TO RECEIVING A CERTIFICATE OF OCCUPANCY.


15. THE CONTRACTOR SHALL PROVIDE ANY AND ALL LAYOUT REQUIRED TO CONSTRUCT HIS WORK UNLESS OTHERWISE DIRECTED BY OWNER.

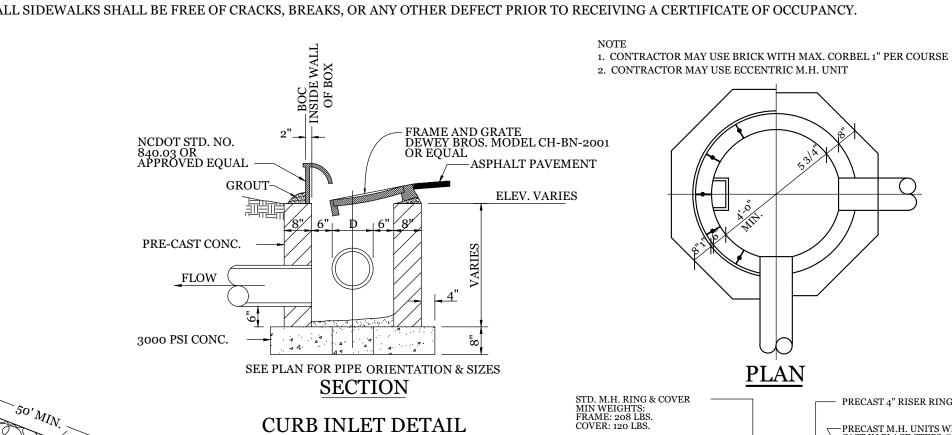

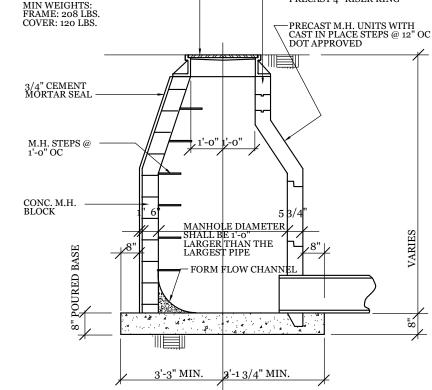


SECTION STORM DRAIN MANHOLE DETAIL

CONC.MH BLOCKS PRECAST MH RINGS

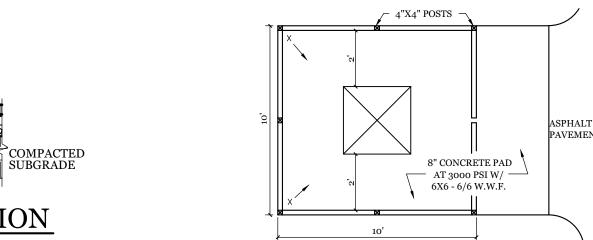

CONCRETE

ASPHALT

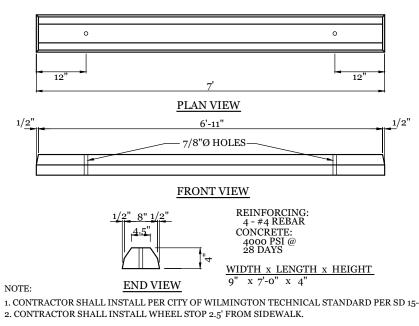

- 4" CONC. SIDEWALK

w/6x6-10/10 W.W.M.

TURNDOWN SIDEWALK

CONCRETE PAVEMENT SECTION


-x x x x

6" CONCRETE

SD 3-10

1. CONTRACTOR SHALL INSTALL PER CITY OF WILMINGTON TECHNICAL STANDARD PER SD 15-13 WHEEL STOP DETAIL

DUMPSTER PAD & ENCLOSURE DETAIL

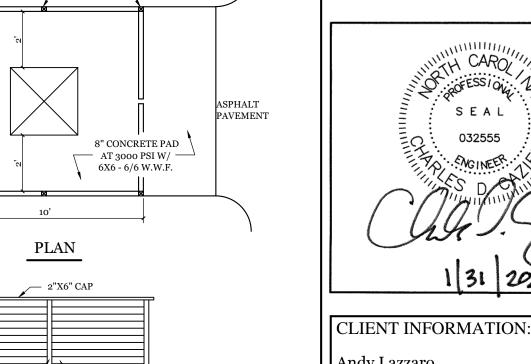

HORIZONTAL

WOOD SIDING

∠ 4"X4" POSTS

ENCLOSURE GATES

W/CROSS-BRACING

ELEVATIONS

(TREATED)

Andy Lazzaro Three Guys Car Wash, Llc 5520 Oleander Dr. Wilmington, NC 28403 DRAWN:

DETAI

24 X 36 JAE SHEET SIZE: CDC DATE: 1/31/2022 CHECKED: CDC | SCALE: APPROVED: NTS PROJECT NUMBER: 2021-035

SEAL

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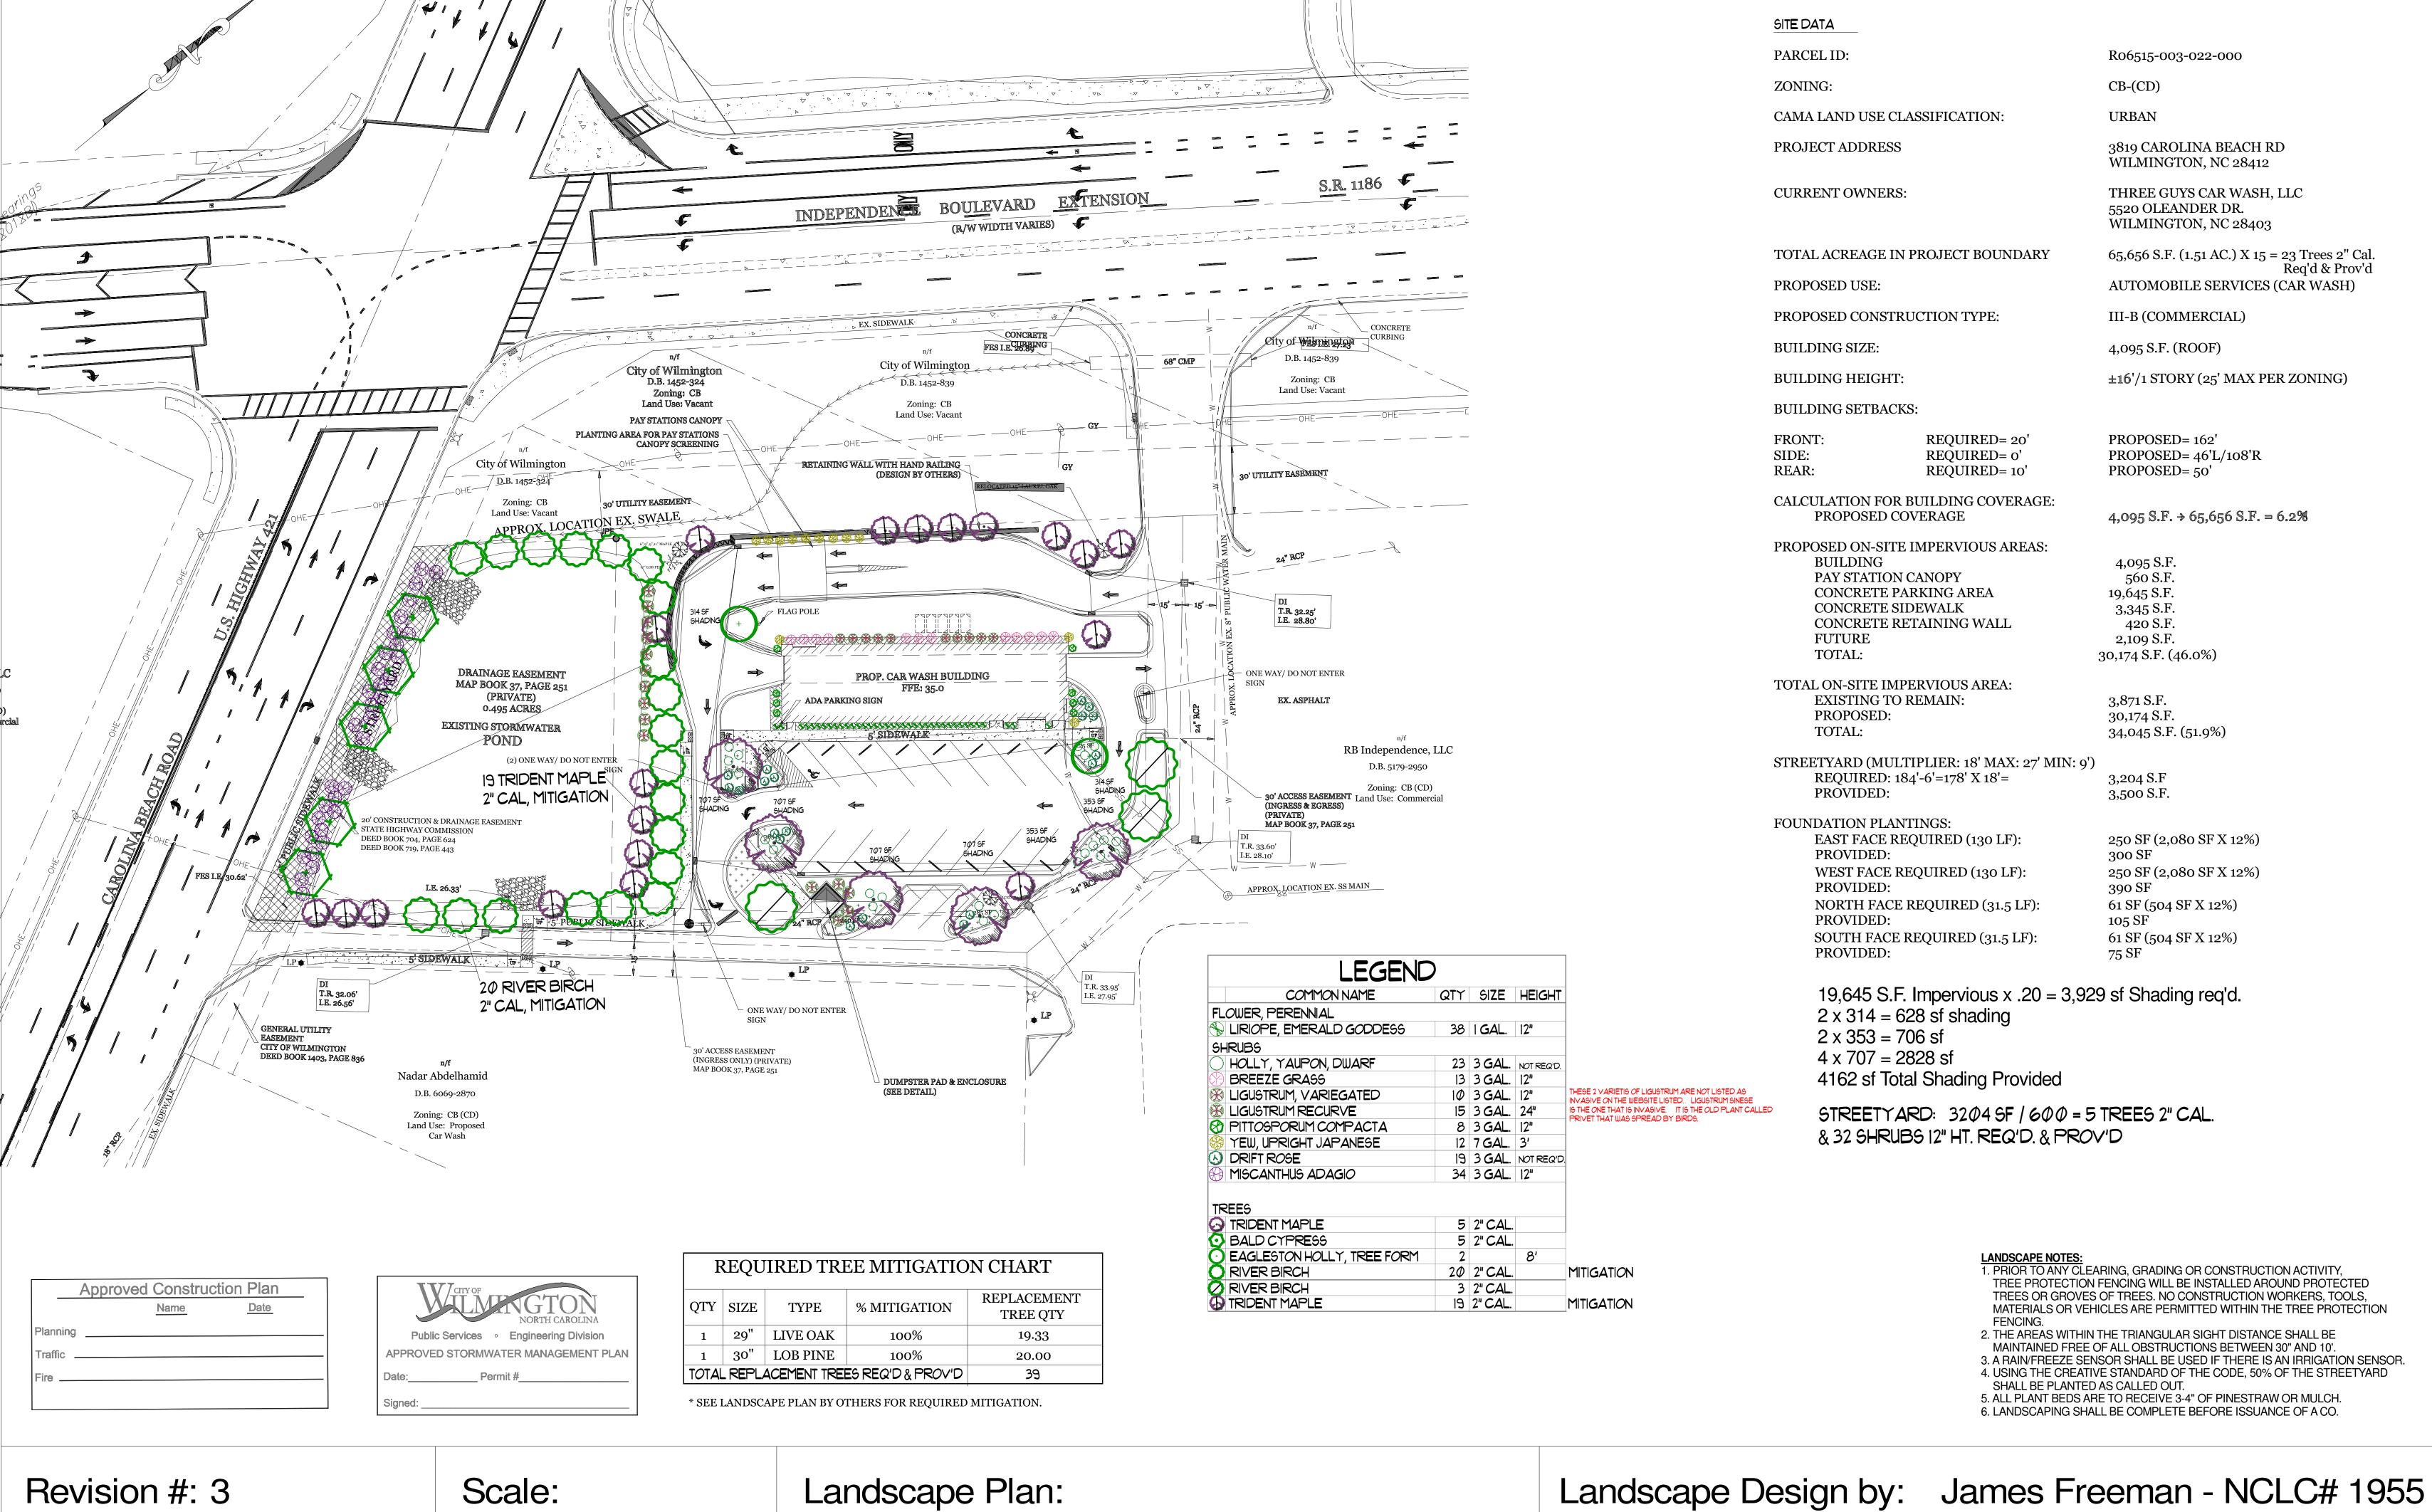
VICINITY MAP (NOT TO SCALE):

REVISIONS

-14-21 REVISED TO SINGLE DUMPSTER PAD E ENCLOSURE DETAIL.

d

DRAWING NUMBER:



Date: 6/15/2022


1'' = 30'

H2 Turbo Carwash

Freeman Landscape

Raleigh, NC 27613 (919) 980.0283 (o)

www.LisleArchitecture.com

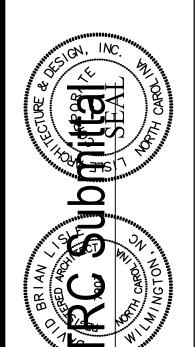

H2 TURBO EXPRESS CARWASH 3819 CAROLINA BEACH RD. WILMINGTON, NC 28412

SHEET TITLE Exterior Elevations


SHEET NUMBER




Exterior Elevation (East)

В 3/16"

A 3/16"

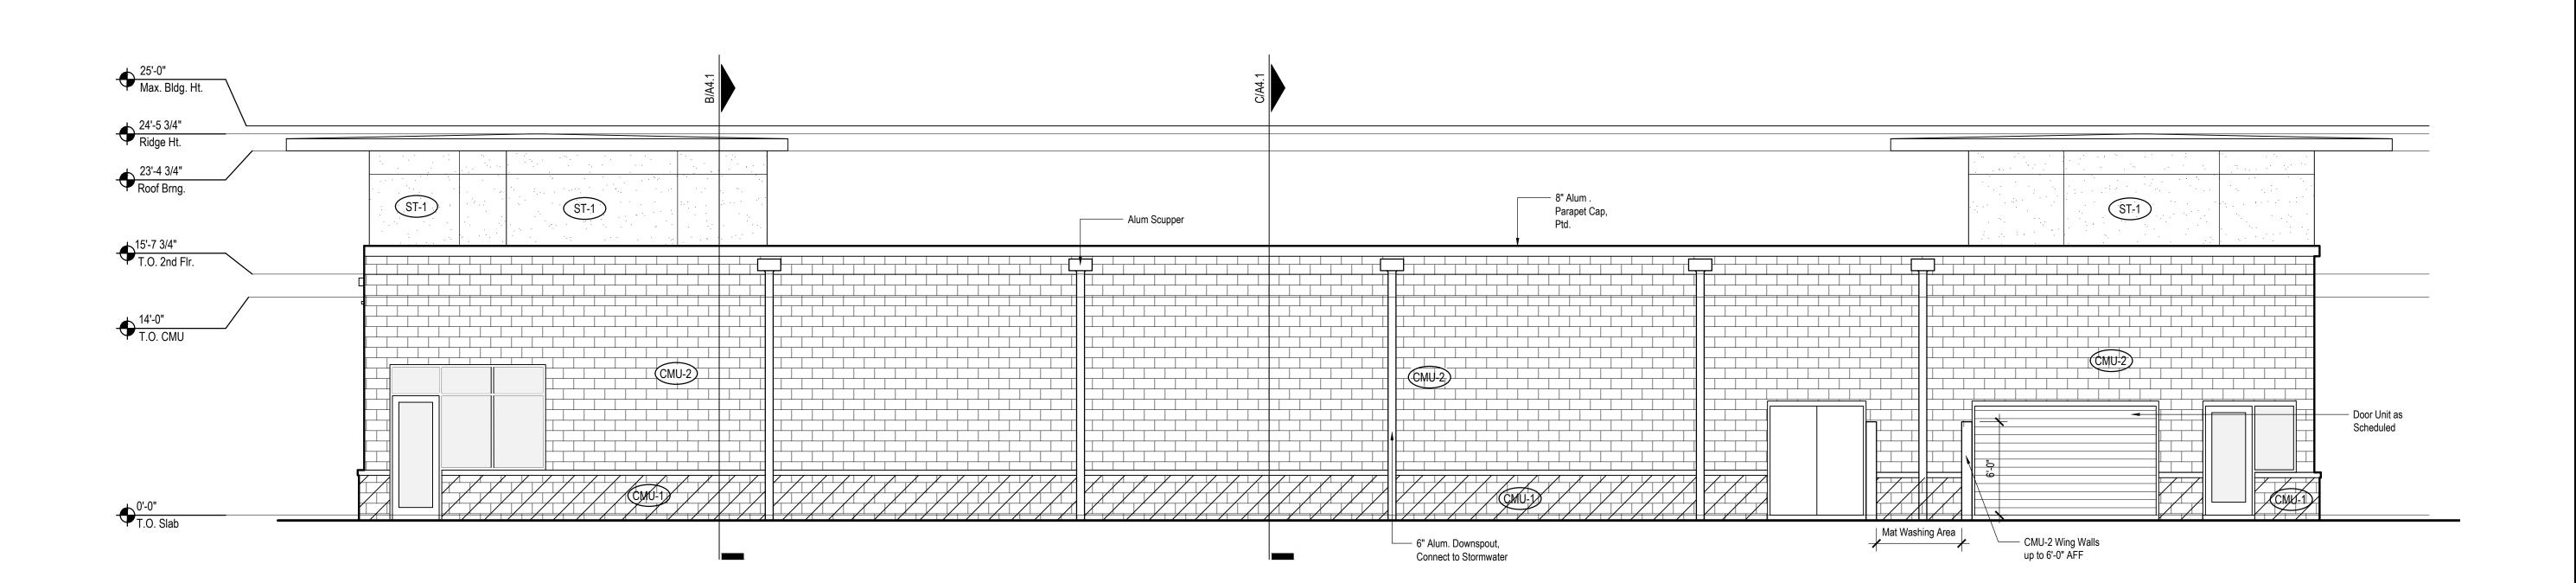

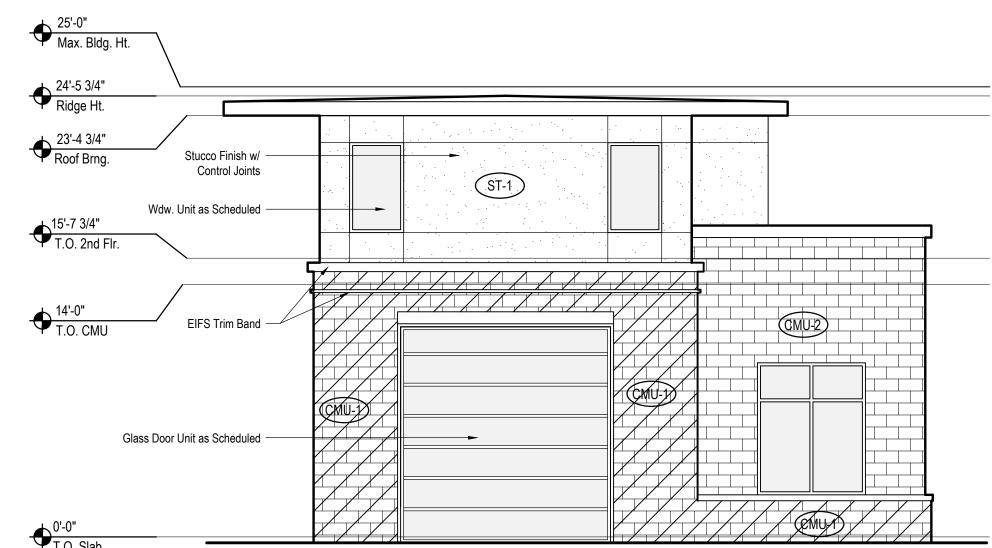


0'-0" T.O. Slab

Exterior Elevation (West)

Exterior Elevation (North)

В 3/16"

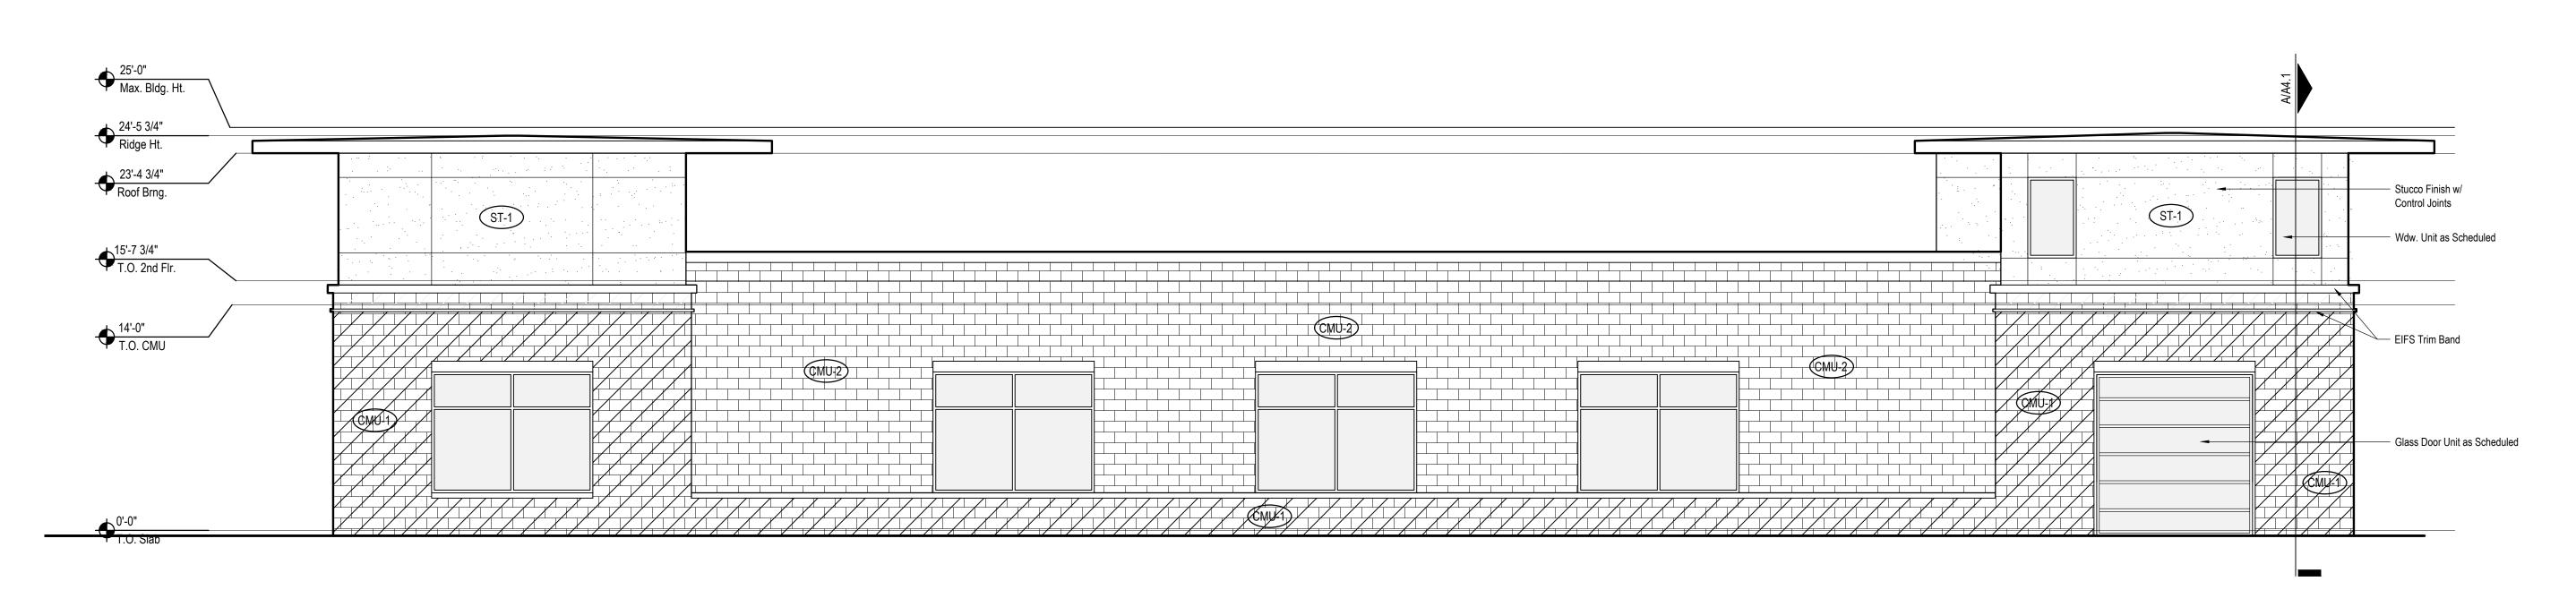

EXTERIOR MATERIAL SCHEDULE

EXTERIOR

MATERIAL

60 MIL EVERGUARD

8" CMU FIELD BLOCK

3-COAT SMOOTH STUCCO

12" SPLITFACE

COLOR

WHITE

4203

7700

PT-1

BY OWNER

MANUFACTURER

FAY BLOCK

FAY BLOCK

SHERWIN WILLIAMS

STO

LOCATION

TYPICAL

ST-1

CMU-2

SEE ELEVATIONS

SEE ELEVATIONS

SEE ELEVATIONS

A 3/16"




Lisle Architecture & Design, Inc.

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H2 TURBO EXPRESS CARWASH 3819 CAROLINA BEACH RD. WILMINGTON, NC 28412

SHEET TITLE **Exterior**

Elevations

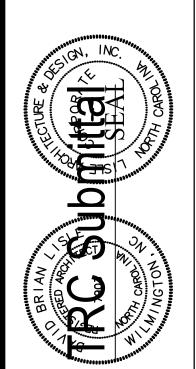SHEET NUMBER